





**RZUT WIĘNCÓW NAD STROPEN**

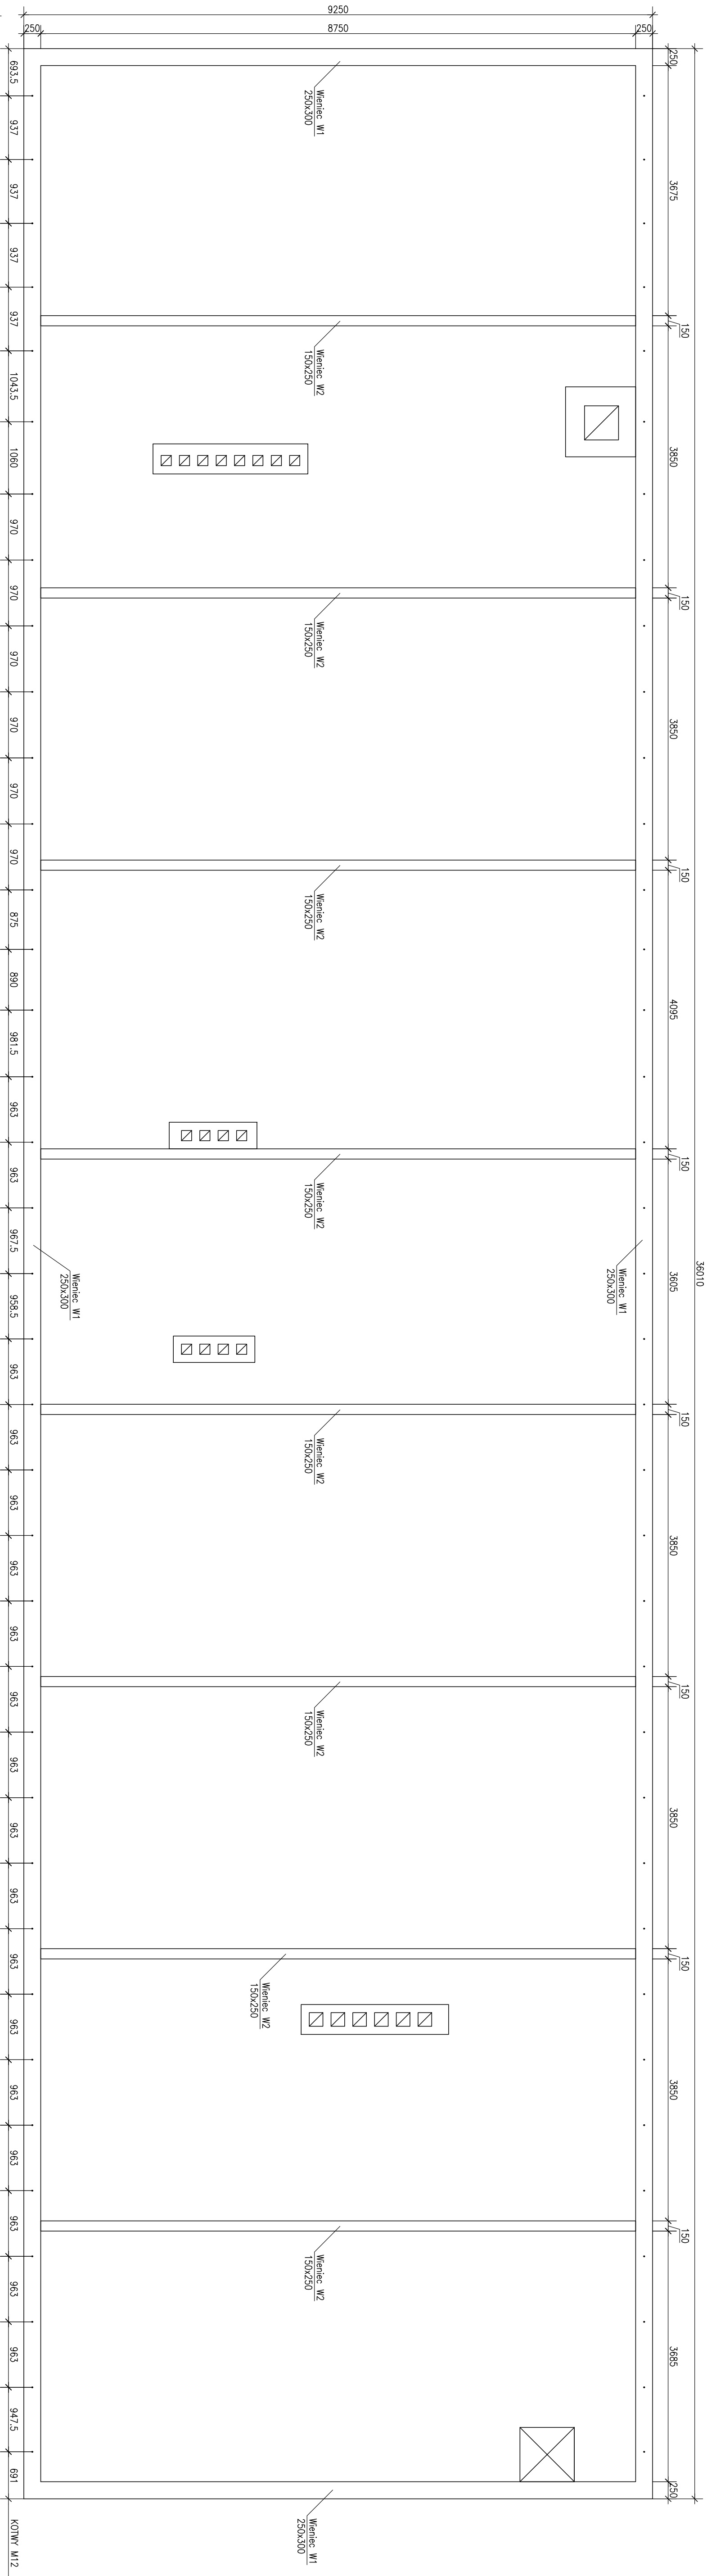

**A**

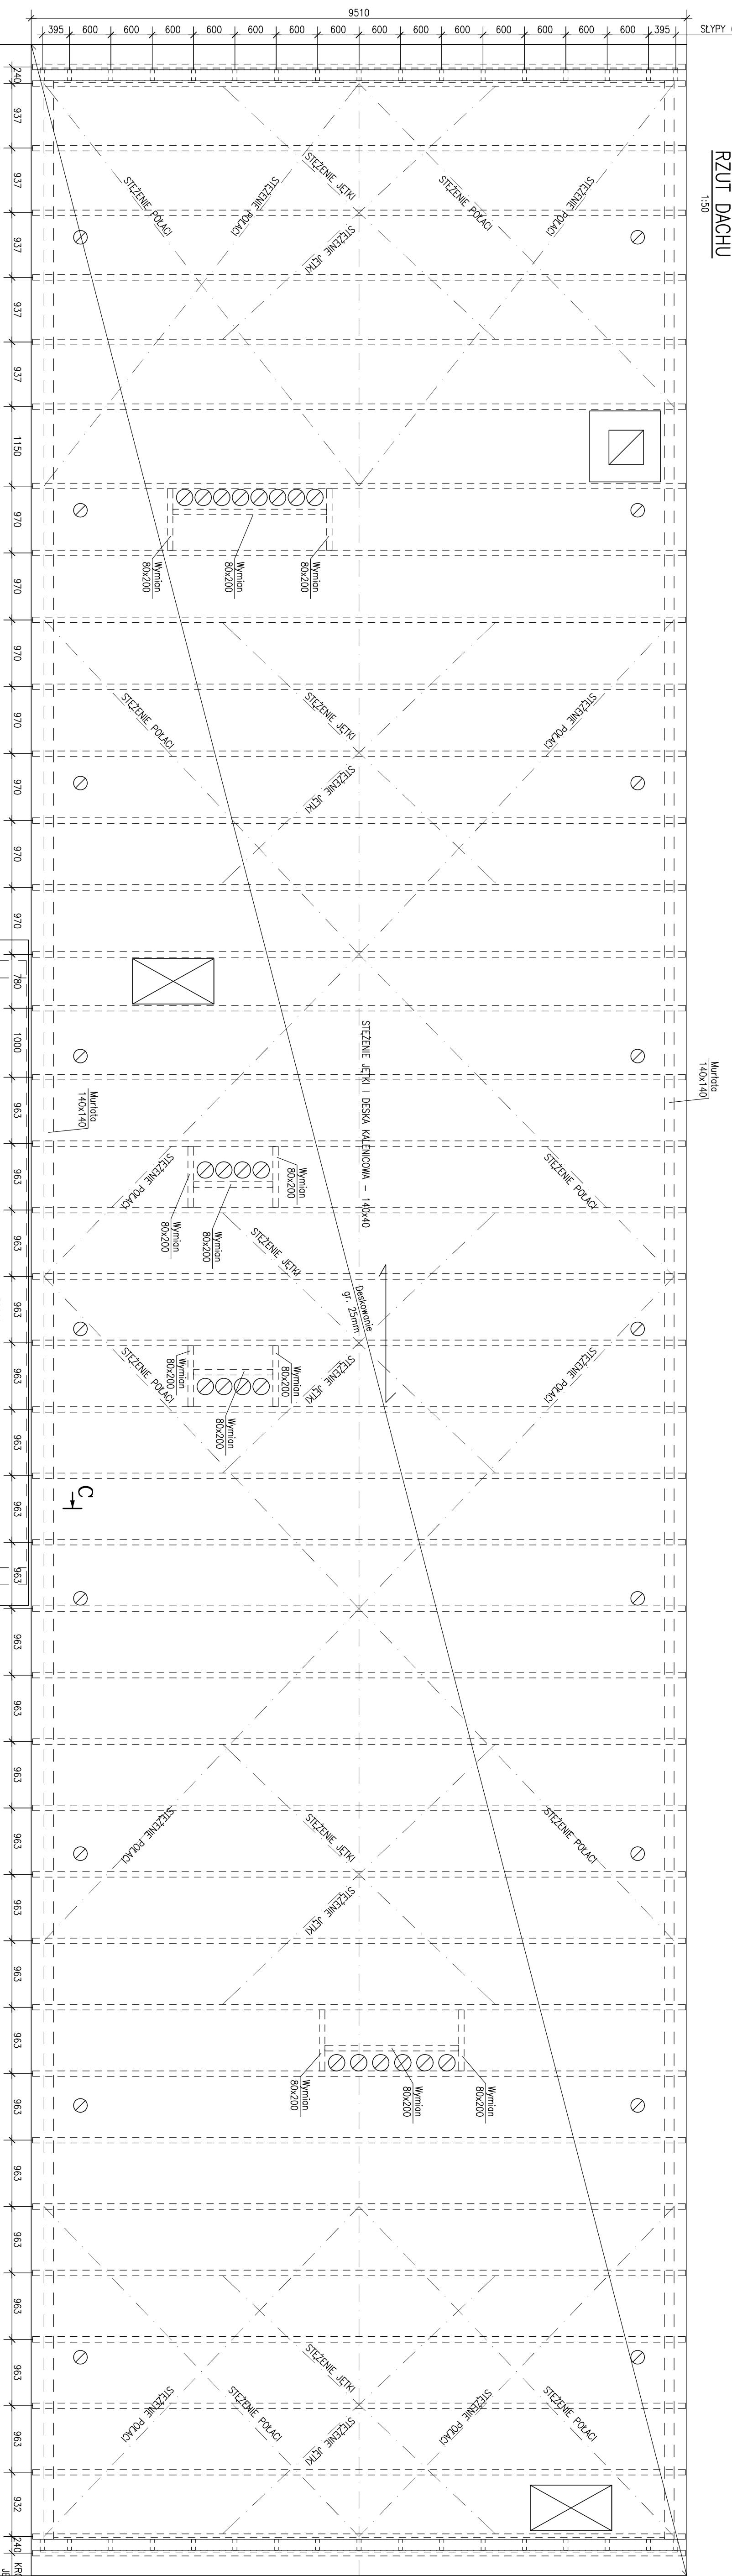


RZUT DACHU

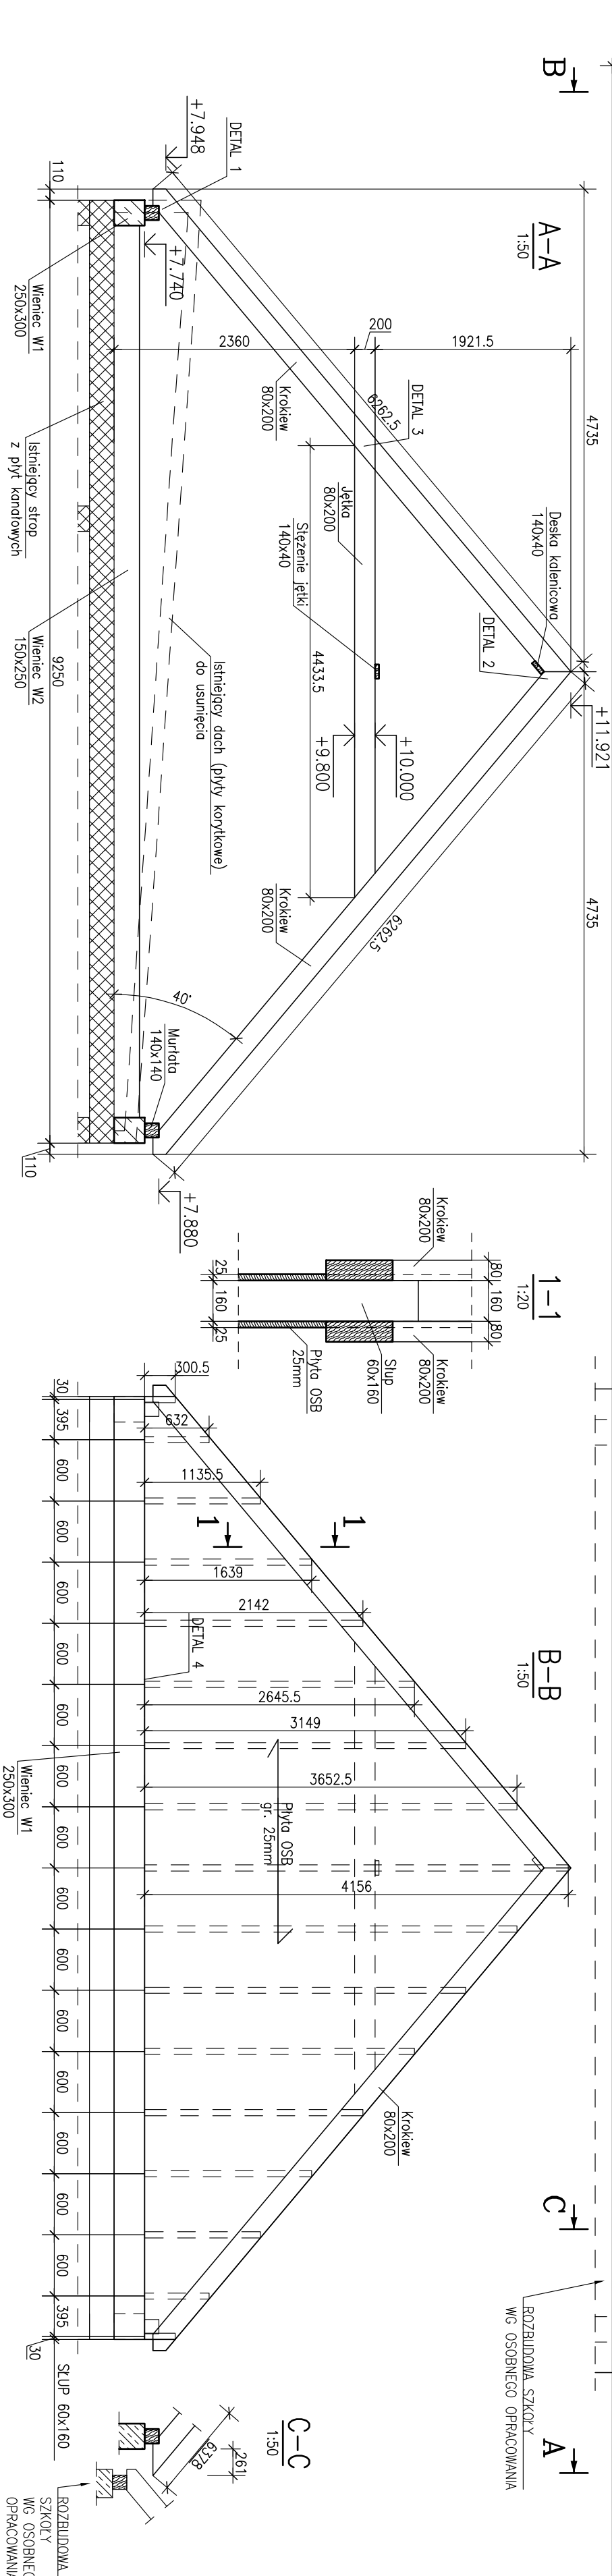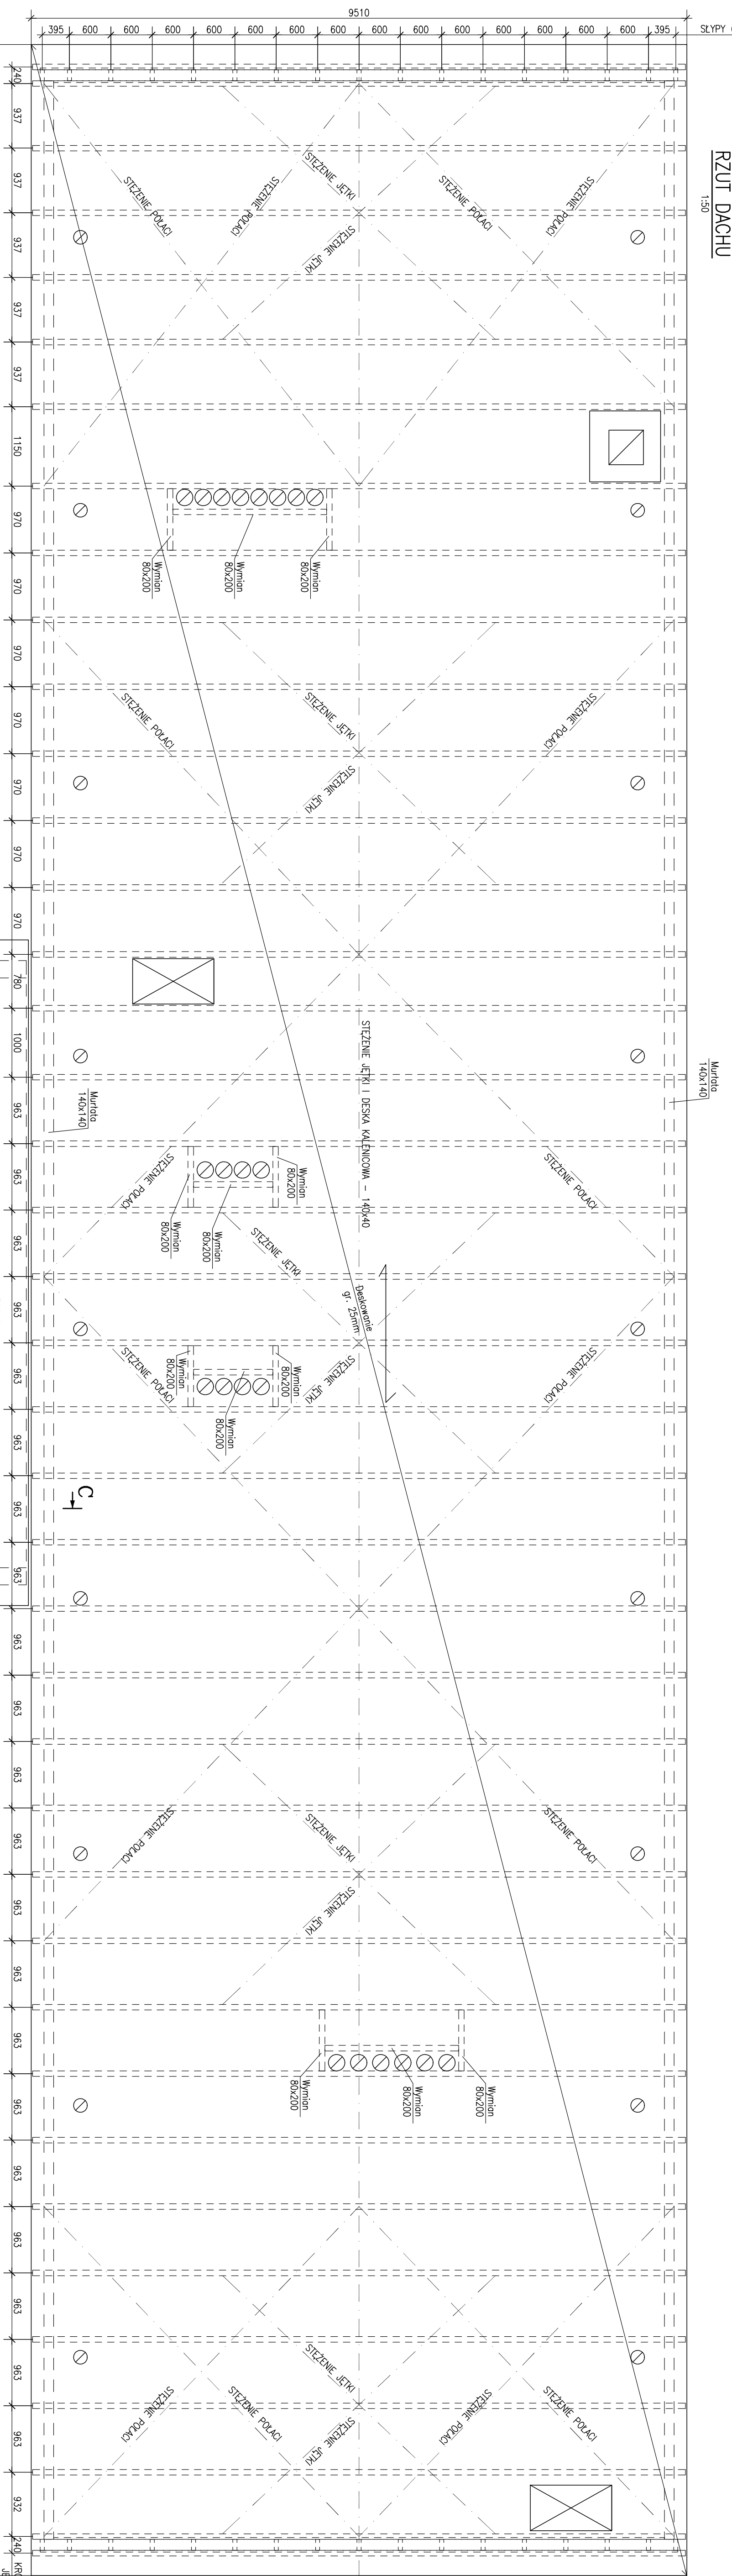[illegible][illegible][illegible]


Architectural cross-section drawing of a building facade. The drawing shows a wall with a brickwork pattern on the left, labeled "Mur z cegły". To the right of the wall is a large window or glass door assembly. The assembly consists of a frame with multiple panes. Dimensions are indicated: 200 for the wall thickness, 1140 for the width of the main window unit, 2090 for the total width including side panels, and 950 for the width of the rightmost side panel. Above the window, there is a section labeled "Bł. Skłó" (Glass) and "L. Skłó" (Glass) with a circled number 2. Below this, there is a section labeled "Bł. Skłó" and "L. Skłó" with a circled number 4. The drawing is a technical architectural drawing with dimensions and labels in Polish.

[illegible]


DETAIL 3  
1:20

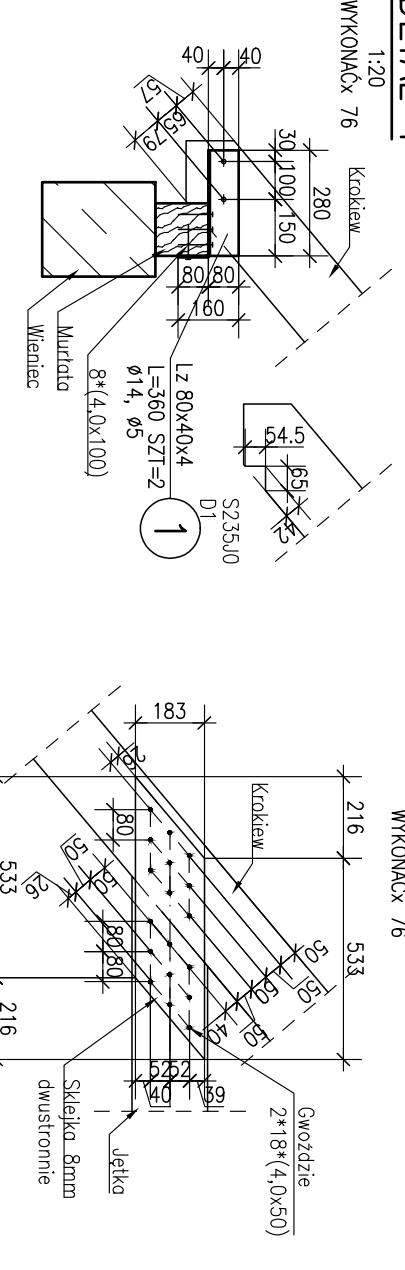


## DETAIL 2

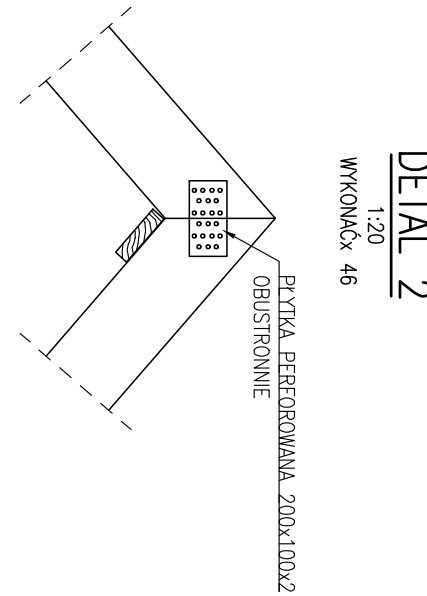


DETAL 5  
1-30

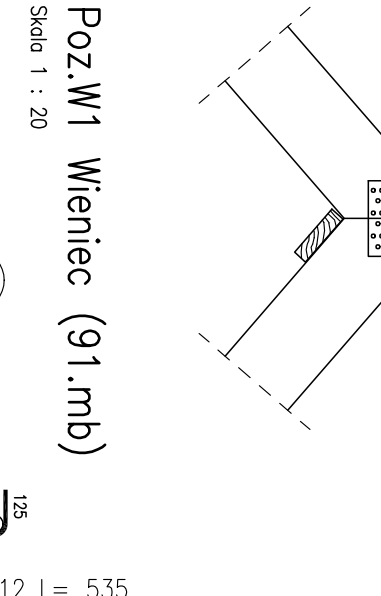

Poz.W1 Wieniec (91.mb)  
Skala 1 : 20

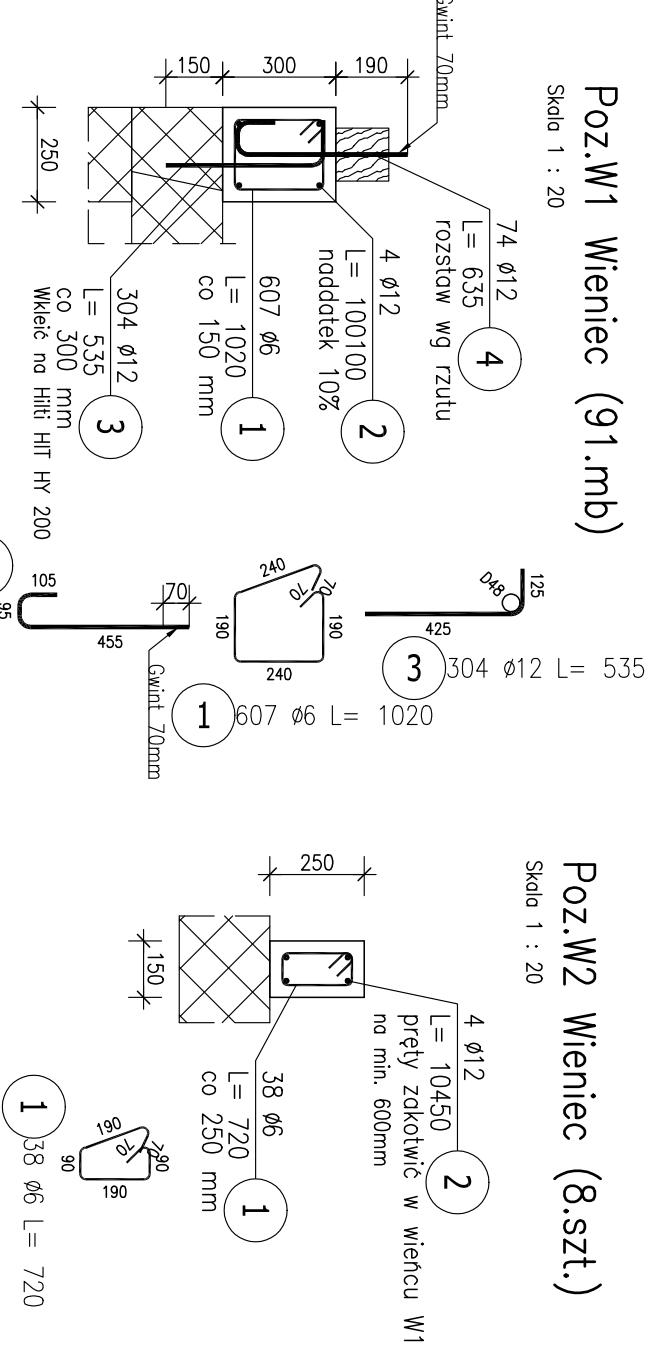

poz. W2 Wieniec (8.szt.)

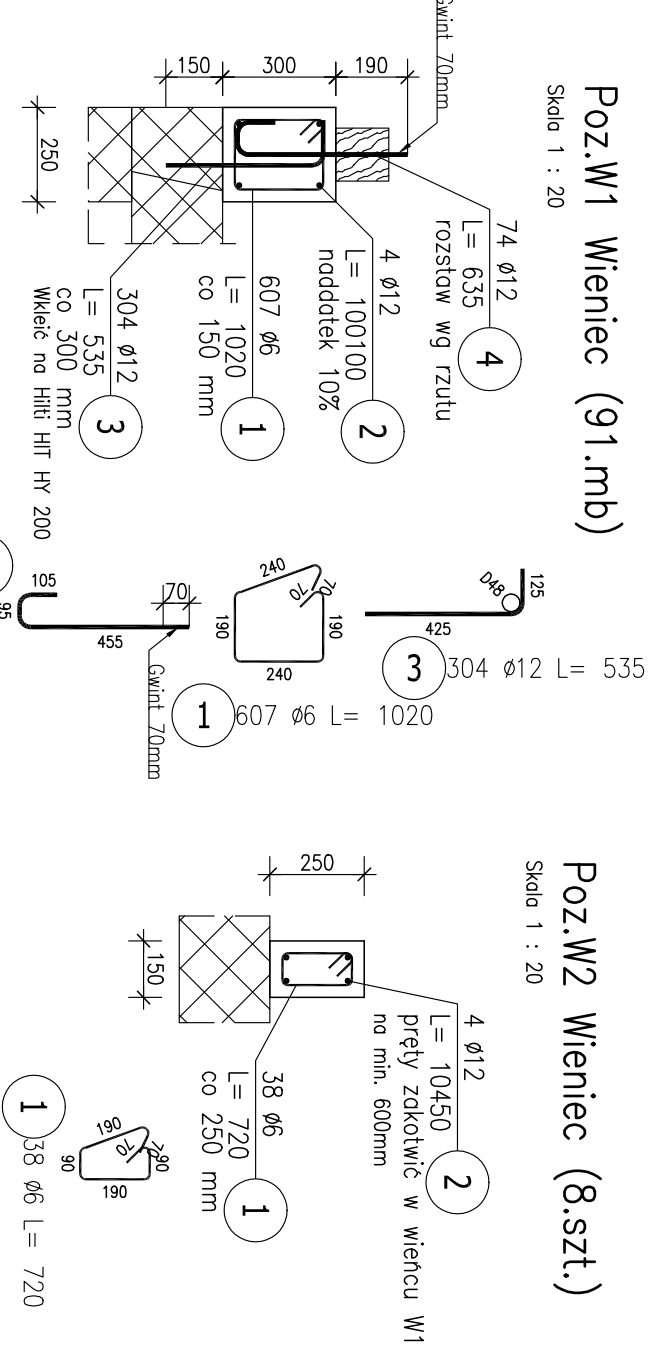


## ZESTAWIENIE STALI ZBROJENIOWEJ

PO2	NR	$\theta$	$\Gamma$ (mJ/cm <sup>2</sup> )	LG55	deg. LG24	A <sub>min</sub>		
IRF	PA			1652	1652	1652		
				W12	deg.	W12		
PO2	W1	1	6	1.000	657	1	657	619.14
	W2	2	12	1.001	160	4	1	400.40
	W3	3	12	0.535	504	4	1	504.4
	W4	4	12	0.535	504	4	1	504.4
	W5	5	12	0.535	504	4	1	463.92
PO2	W2	W2	W2	W2	W2	W2	W2	W2
W2	1	6	0.720	38	8	354	2718.88	333.445
W2	2	12	0.720	4	8	32		
W2	3	12	0.720	4	8	32		
W2	4	12	0.720	4	8	32		
W2	54	12	0.720	4	8	32		
W2								

W2	55	56	57	58	59	60	61	62	63	64	65	66	67	68	69	70	71	72	73	74	75	76	77	78	79	80	81	82	83	84	85	86	87	88	89	90	91	92	93	94	95	96	97	98	99	100																																																																																																																																																																																																																																																																																																																																																																																																																																																																																																																										
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/zmocnienie filarków na parterze

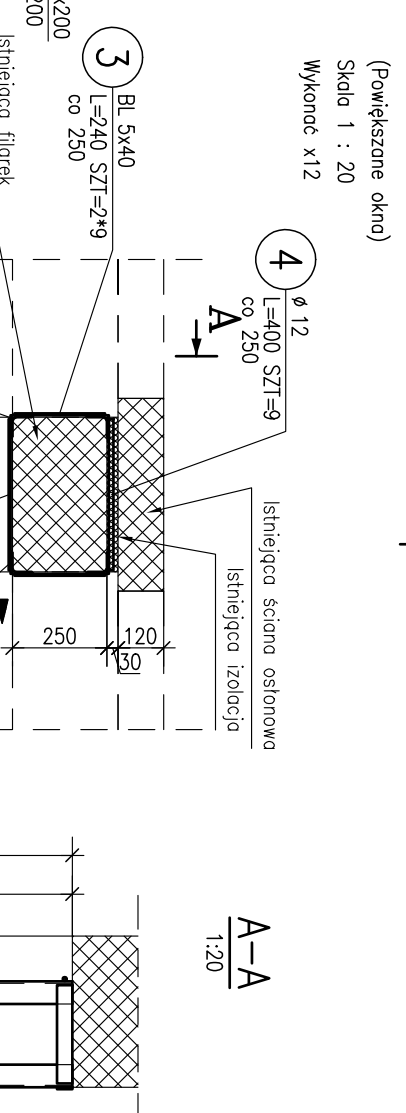

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[illegible]